

**City of Glendale  
Community Development Department  
Design Review Staff Report – Single Family**

<b>Meeting/Decision Date:</b> April 15, 2019	<b>Address:</b> 1325 Sonora Avenue
<b>Review Authority:</b> <input type="checkbox"/> DRB <input checked="" type="checkbox"/> ADR <input type="checkbox"/> HPC <input type="checkbox"/> CC	<b>APN:</b> 5622-022-032
<b>Case Number:</b> PDR1828390	<b>Applicant:</b> Aram Mnatsakanian
<b>Prepared By:</b> Cassandra Pruett	<b>Owner:</b> Yervand Minasyan

**Project Summary**

The applicant is proposing a 332 square-foot (SF), one-story addition at the southwest (left) façade of an existing one-story, 1,523 SF single-family house (built in 1925) and located on a 9,576 SF lot zoned R1-I.

**Existing Property/Background**

The subject property is a 9,576 SF interior lot on the west side of Sonora Avenue. The lot is rectangular in shape and relatively flat. The property is improved with an existing one-story, 1,523 SF single-family house with a detached two-car garage. The proposed project is in the R1-I (Residential) Zone, Floor Area Ratio District I and complies with all current Zoning Code requirements, including setbacks, lot coverage, floor area ratio, parking, and landscaping.

**Staff Recommendation**

☐ Approve ☒ Approve with Conditions ☐ Return for Redesign ☐ Deny

**Last Date Reviewed / Decision**

☒ First time submittal for final review.  
☐ Other:

**Zone: R1 FAR District: I**

Although this design review does not convey final zoning approval, the project has been reviewed for consistency with the applicable Codes and no inconsistencies have been identified.

**Active/Pending Permits and Approvals**

☒ None  
☐ Other:

**CEQA Status:**

☒ The project is exempt from CEQA review as a Class 1 "Existing Facilities" exemption pursuant to Section 15301 of the State CEQA Guidelines because the proposed project is an addition to an existing structure that will not result in an increase of more than 50 percent of the floor area before the addition, or 2,500 square feet, whichever is less.

☐ The project is exempt from CEQA review as a Class 3 "New Construction or Conversion of Small Structures" exemption pursuant to Section 15303 of the State CEQA Guidelines because

☐ Other:

**Site Slope and Grading**

☒ None proposed  
☐ Less than 50% current average slope and less than 1500 cubic yards of earth movement (cut and/or fill); no additional review required.

☐ 1500 cubic yards or greater of earth movement:

☐ 50% or greater current average slope:

Comparison of Neighborhood Survey:

	Average of Properties within 300 linear feet of subject property	Range of Properties within 300 linear feet of subject property	Subject Property Proposal
Lot size	9,271	7,030-11,732 SF	9,576
Setback	40'	27'-7" - 58'-3"	35'
House size	1,654 SF	960 - 2,758 SF	1,855
Floor Area Ratio	18%	8 - 29%	20%
Number of stories	1.2	1 - 2	1
	13 one-story houses		
	3 two-story houses		

DESIGN ANALYSIS

Site Planning

Are the following items satisfactory and compatible with the project site and surrounding area?

Building Location

☒ yes   ☐ n/a   ☐ no

If "no" select from below and explain:

- ☐ Setbacks of buildings on site
- ☐ Prevailing setbacks on the street
- ☐ Building and decks follow topography

Garage Location and Driveway

☐ yes   ☒ n/a   ☐ no

If "no" select from below and explain:

- ☐ Predominant pattern on block
- ☐ Compatible with primary structure
- ☐ Permeable paving material
- ☐ Decorative paving

Landscape Design

☐ yes   ☒ n/a   ☐ no

If "no" select from below and explain:

- ☐ Complementary to building design
- ☐ Maintains existing trees when possible
- ☐ Maximizes permeable surfaces
- ☐ Appropriately sized and located

Walls and Fences

☐ yes   ☒ n/a   ☐ no

If "no" select from below and explain:

- ☐ Appropriate style/color/material
- ☐ Perimeter walls treated at both sides
- ☐ Retaining walls minimized

☐ Appropriately sized and located

**Determination of Compatibility: Site Planning**

The proposed site planning is appropriate, as modified by any proposed conditions, to the site and its surroundings for the following reasons:

- The 332 SF addition is an up to nine-foot wide addition for the length of the existing house that maintains the required four-foot interior setback.
- The addition maintains the prevailing street-front setback, and its placement is consistent with neighboring houses that have front facades extending the full width of the property.

**Massing and Scale**

Are the following items satisfactory and compatible with the project site and surrounding area?

**Building Relates to its Surrounding Context**

☒ yes   ☐ n/a   ☐ no

*If "no" select from below and explain:*

- ☐ Appropriate proportions and transitions
- ☐ Relates to predominant pattern
- ☐ Impact of larger building minimized

**Building Relates to Existing Topography**

☒ yes   ☐ n/a   ☐ no

*If "no" select from below and explain:*

- ☐ Form and profile follow topography
- ☐ Alteration of existing land form minimized
- ☐ Retaining walls terrace with slope

**Consistent Architectural Concept**

☒ yes   ☐ n/a   ☐ no

*If "no" select from below and explain:*

Concept governs massing and height

**Scale and Proportion**

☒ yes   ☐ n/a   ☐ no

*If "no" select from below and explain:*

- ☐ Scale and proportion fit context
- ☐ Articulation avoids overbearing forms
- ☐ Appropriate solid/void relationships
- ☐ Entry and major features well located
- ☐ Avoids sense of monumentality

**Roof Forms**

☒ yes   ☐ n/a   ☐ no

*If "no" select from below and explain:*

- ☐ Roof reinforces design concept
- ☐ Configuration appropriate to context



Determination of Compatibility: Mass and Scale

The proposed massing and scale are appropriate, as modified by any proposed conditions, to the site and its surroundings for the following reasons:

- The minor addition consists of an extension of the front façade by approximately five feet.
- The addition continues the existing roof and wall line at the front and the decorative roof and wing wall forms at the location of the addition. These roof and wall forms break up the massing and are consistent with the existing Spanish Revival style.
- The addition on the southwest façade (facing the neighbor) maintains a variation in planes to help break up the massing.

Design and Detailing

Are the following items satisfactory and compatible with the project site and surrounding area?

Overall Design and Detailing

☒ yes   ☐ n/a   ☐ no

Entryway

☐ yes   ☒ n/a   ☐ no

If "no" select from below and explain:

- ☐ Well integrated into design
- ☐ Avoids sense of monumentality
- ☐ Design provides appropriate focal point
- ☐ Doors appropriate to design

Windows

☒ yes   ☐ n/a   ☐ no

If "no" select from below and explain:

- ☐ Appropriate to overall design
- ☐ Placement appropriate to style
- ☐ Recessed in wall, when appropriate

Privacy

☒ yes   ☐ n/a   ☐ no

If "no" select from below and explain:

- ☐ Consideration of views from "public" rooms and balconies/decks
- ☐ Avoid windows facing adjacent windows

Finish Materials and Color

☒ yes   ☐ n/a   ☐ no

If "no" select from below and explain:

- ☐ Textures and colors reinforce design
- ☐ High-quality, especially facing the street
- ☐ Respect articulation and façade hierarchy
- ☐ Wrap corners and terminate appropriately
- ☐ Natural colors used in hillside areas



**Paving Materials**

☐ yes ☒ n/a ☐ no

*If "no" select from below and explain:*

- ☐ Decorative material at entries/driveways
- ☐ Permeable paving when possible
- ☐ Material and color related to design

**Equipment, Trash, and Drainage**

☐ yes ☒ n/a ☐ no

*If "no" select from below and explain:*

- ☐ Equipment screened and well located
- ☒ Trash storage out of public view
- ☐ Downspouts appropriately located
- ☐ Vents, utility connections integrated with design, avoid primary facades

**Ancillary Structures**

☐ yes ☒ n/a ☐ no

*If "no" select from below and explain:*

- ☐ Design consistent with primary structure
- ☐ Design and materials of gates complement primary structure

**Determination of Compatibility: Design and Detailing**

The proposed design and detailing are appropriate, as modified by any proposed conditions, to the site and its surroundings for the following reasons:

- The proposed modifications are consistent with the existing Spanish Revival style house. The stucco on the entire house is being updated to a smooth finish with a light gray color which, along with the Spanish tile roofing on the parapet, will continue onto the addition.
- The new front façade window duplicates the existing adjacent window in style and appearance, including the arched stucco imprint above the window which is a common Spanish Revival feature.
- All new and replacement windows visible from the street are recessed with wood trim and sill to match the original windows on the house.
- New window locations are staggered from windows on the adjacent house to preserve privacy.

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**Recommendation / Draft Record of Decision**

Based on the above analysis, staff recommends **approval** of the project with **conditions**, as follows:

**Conditions**

1. Replace any existing windows visible from the street that are sliding, or have internal grids, in order to comply with the Window Replacement Design Guidelines. Maintain window operation of all existing double casement windows visible from street, unless required by Building Code to be single casement.

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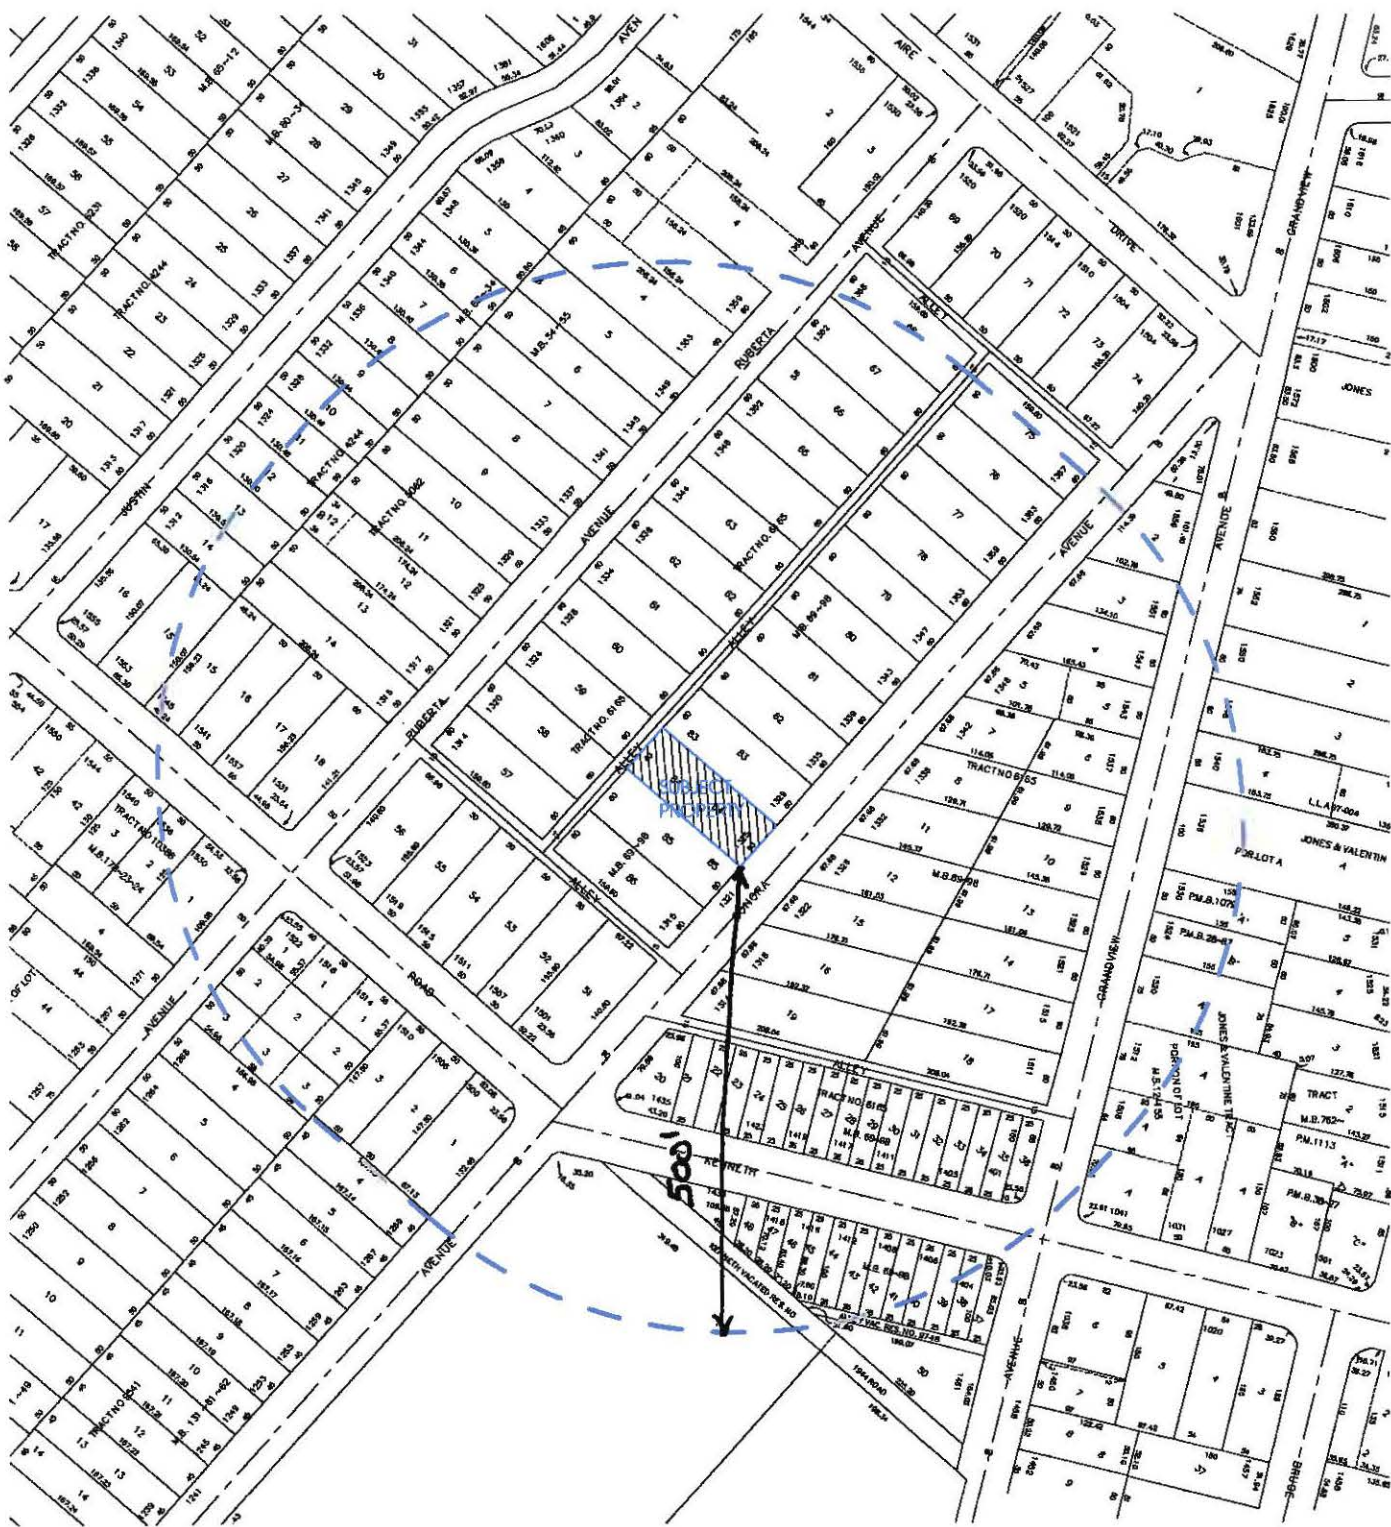
**Attachments**

1. Location Map
2. Neighborhood Survey
3. Photos of Existing Property
4. Reduced Plans





**LOCATION MAP**  
SCALE: 1"=200'



--- 500' RADIUS

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& CONSTRUCTION



SURVEY LIST

	ADDRESS	HEIGHT (STORIES)	FAR	SETBACK	HOUSE SIZE (SQFT.)	LOT SIZE (SQFT.)
1	1501 W. KENNETH RD.	1	0.16	50'-9"	1,749	10,754
2	1315 SONORA AVE.	1	0.17	42'-11"	1,580	9,189
3	1321 SONORA AVE.	1	0.19	41'-1"	1,819	9,562
4	1329 SONORA AVE.	1	0.13	42'-10"	1,268	9,574
5	1335 SONORA AVE.	1	0.18	40'-8"	1,713	9,549
6	1339 SONORA AVE.	1	0.16	41'-2"	1,534	9,564
7	1343 SONORA AVE.	2	0.15	41'-5"	1,482	9,653
8	1347 SONORA AVE.	2	0.29	38'-7"	2,758	9,453
9	1348 SONORA AVE.	1	0.23	27'-7"	1,248	5,525
10	1342 SONORA AVE.	1	0.27	27'-10"	1,928	7,030
11	1338 SONORA AVE.	1	0.21	36'-6"	1,584	7,611
12	1332 SONORA AVE.	1	0.20	37'-3"	1,742	8,555
13	1328 SONORA AVE.	1	0.16	46'-5"	1,566	9,502
14	1322 SONORA AVE.	1	0.16	35'-9"	1,548	9,857
15	1318 SONORA AVE.	2	0.18	38'-6"	1,987	11,229
16	1314 SONORA AVE.	1	0.08	58'-3"	960	11,732
17	1435 KENNETH RD. (NON RESIDENTIAL)	1	0.09	0'-0"	640	7,464

AVG

1-17  
2-3

.18

40'

1,654

9,271



SUBJECT PROPERTY FROM SONORA AVE.



ENTRY VIEW









WEST ELEVATION



EAST ELEVATION



BACKYARD\_1



BACKYARD\_2

# DRAWING INDEX

A-1	INDEX, INFORMATION, SCOPE OF WORK, PLOT PLAN
A-1.1	SITE PLAN W/ CONTEXT (1/8" SCALE)
A-2	EXISTING FLOOR PLAN, PROPOSED FLOOR PLAN
A-3	SECTIONS, ROOF PLAN
A-4.1	COLORS ELEVATIONS
A-4.2	COLORS ELEVATIONS
A-4.3	ELEVATIONS, WINDOW SCHEDULE
A-4.4	ELEVATIONS
L-1	LANDSCAPING PLAN

# LEGAL DESCRIPTION

APN: 5622022032  
TAX RATE AREA (TRA): 04045  
TRACT #: 6165  
LOT: 84  
ZONE: R1 1

# SCOPE OF WORK

332 S.F. ADDITION TO EX. SFD

# BUILDING TYPE

TYPE V-B  
MAX HEIGHT 15'-0"  
Y.B. 1925/1935

# BUILDING USE

SINGLE FAMILY RESIDENTIAL R-3

# FAR CALCULATION

PROPERTY 9,576 S.F.  
EX. HOUSE 1,523 S.F.  
EX. FRONT PORCH 113 S.F.  
EX. GARAGE 539 S.F.  
PROPOSED ADDITION 332.2 S.F.  
TOTAL HOUSE 1,855.2 S.F.

MAX FAR ALLOWABLE:  
 $9,576 \times 30\% = 2,872.8$  S.F.  
 $(1,855.2 + 539 - 500) = 1,894.2/9576 = 19.8\%$   
 $1894.2 < 2,872.8$

# LOT COVERAGE

$9,576 \times 40\% = 3,830$  S.F.  
 $1,855.2 + 113 + 539 = 2,507.2$   
 $2,507.2 < 3,830$

# LANDSCAPING

$9,576 \times 40\% = 3,830$  S.F.  
LANDSCAPING: A = 1793.7 S.F.,  
B = 2347.5 S.F.,  
C = 106 S.F.  
 $1793.7 + 2347.5 + 106 = 4,247.2$  S.F.  
 $4,247.2 > 3,830$

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409 IRVING DR.  
BURBANK, CA 91504

OWNER VERVAND MINASYAN 818-631-6008

PROJECT ADDITION TO EXISTING 1 STORY S.F.D.

LOCATION 1325 SONORA AVE., GLENDALE, CA 91201

AS INSTRUMENT OF SERVICE, ALL DESIGN, IDEAS AND INFORMATION SHOWN ON THESE DRAWINGS ARE AND SHALL REMAIN THE PROPERTY OF ARCH DESIGN & CONSTRUCTION, NO PART THEREOF SHALL BE COPIED, DISCLOSED TO OTHERS, OR USED IN CONNECTION WITH ANY WORK OR PROJECT OTHER THAN THE SPECIFIC PROJECT FOR WHICH THEY HAVE BEEN PREPARED AND DEVELOPED WITHOUT THE WRITTEN CONSENT OF ARCH DESIGN & CONSTRUCTION. VISUAL CONTACT WITH THESE DRAWINGS SHALL CONSTITUTE CONCLUSIVE EVIDENCE OF ACCEPTANCE OF THESE RESTRICTIONS.

CONTRACTOR TO VERIFY ALL DIMENSIONS, CONDITIONS, ETC., PERTAINING TO THE WORK AT THE SITE BEFORE PROCEEDING WITH WORK.

# REVISIONS


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DESIGN BY	ARAM M.
SCALE	
DATE	
JOB NO.	

SHEET NUMBER:

A-1

OF SHEETS



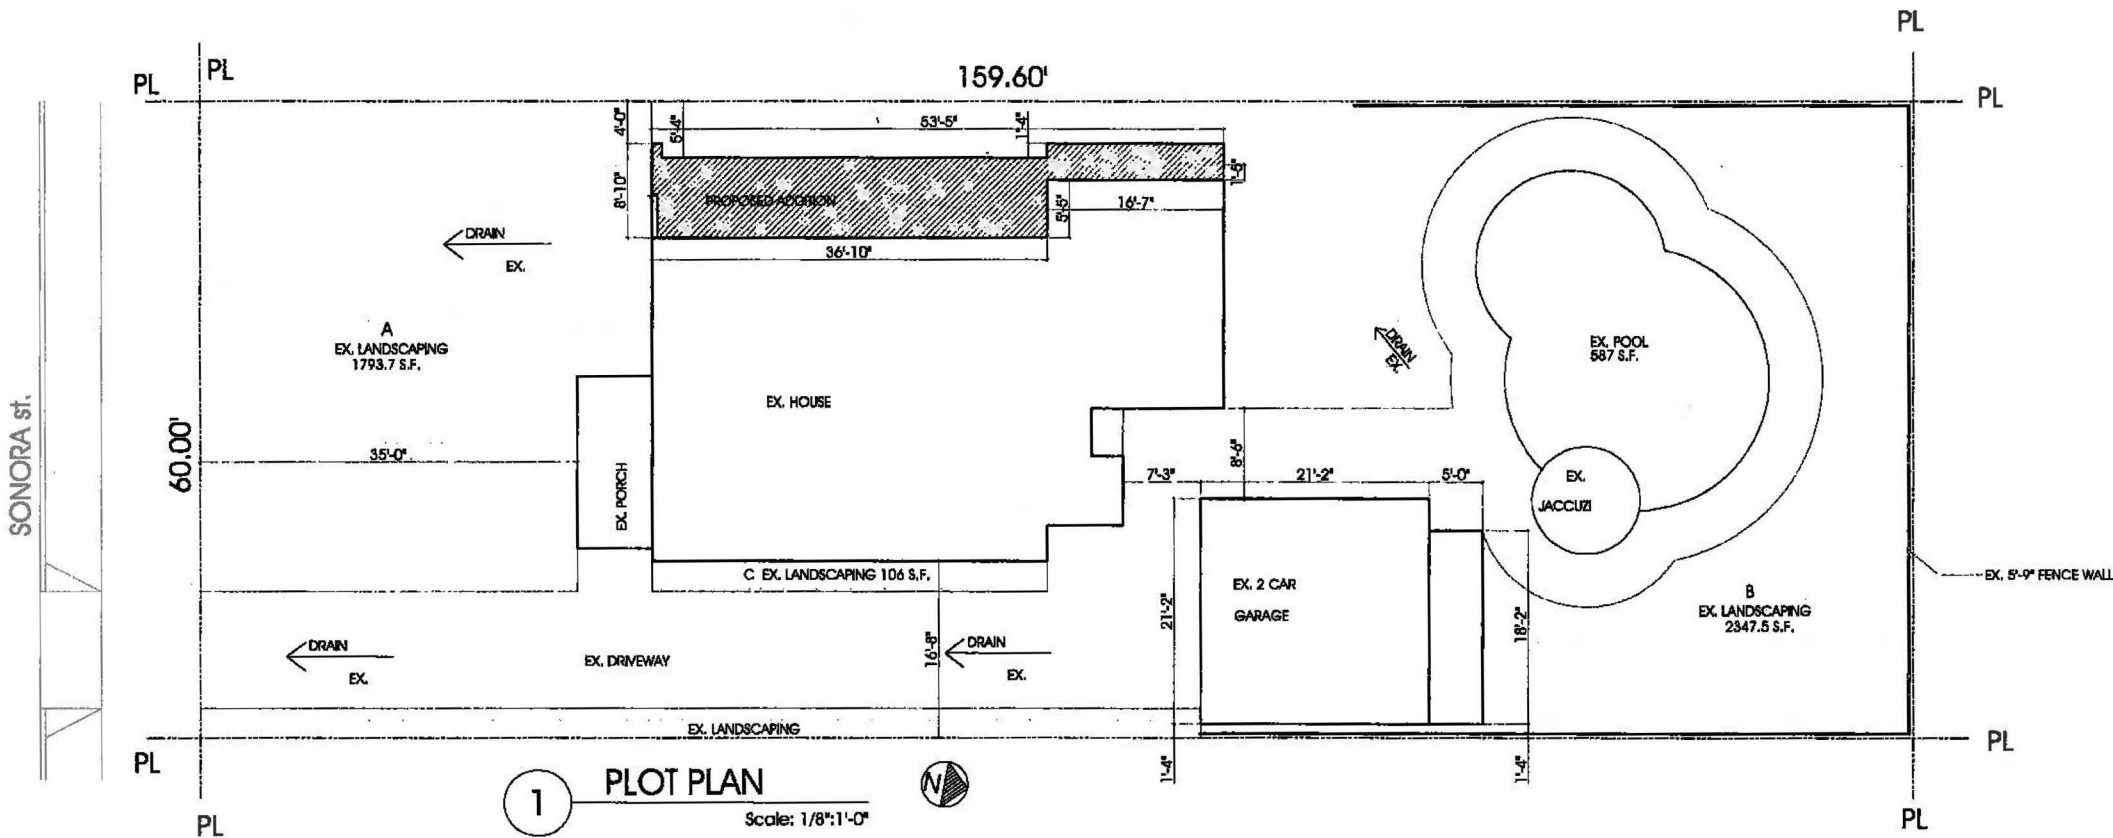



NOTE: FOR EXISTING TREE TYPE AND SIZE SEE L-1

### LEGAL DESCRIPTION

APN: 5622022032  
TAX RATE AREA (TRA): 04046  
TRACT #: 6165  
LOT: 84  
ZONE: R1 1

### SCOPE OF WORK

332 S.F. ADDITION TO EX. SFD

### FAR CALCULATION

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 $1793.7 + 2347.5 + 106 = 4,247.2$  S.F.  
 $4,247.2 > 3,830$

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TEL (818) 517-5224

102 E. PROSPECT AVE.,  
BURBANK, CA 91502

OWNER: YERVAND MINASYAN 818-631-6008

PROJECT: ADDITION TO EXISTING 1 STORY S.F.D.

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A-1.1


THERE ARE NO PROTECTED BAY, OAK, OR SYCAMORE TREES ON THE PROPERTY. ONLY CITY TREES LOCATED ADJACENT TO THE SUBJECT PROPERTY.

CITY TREE NOTE: ALL CITY STREET TREES TO BE PRESERVED IN PLACE WITH NO IMPACT FROM CONSTRUCTION


1 SITE PLAN




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1.1 EXISTING GARAGE FLOOR PLAN  
Scale: 1/4"=1'-0"

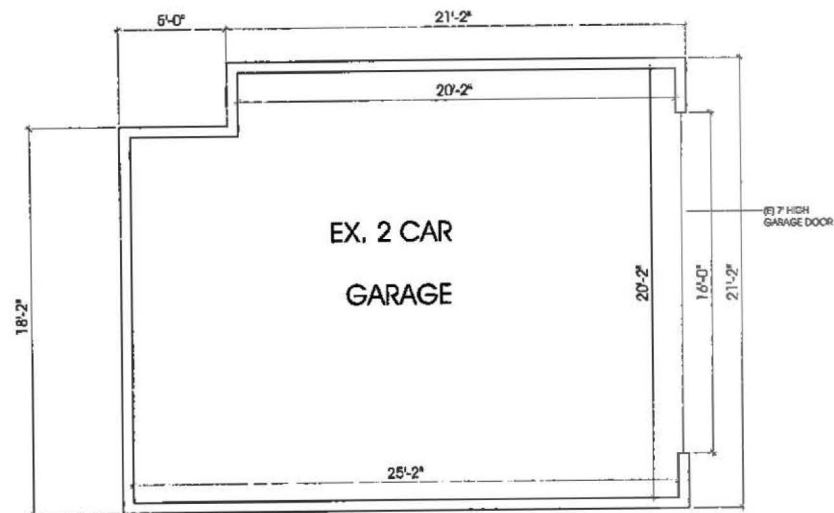

2 PROPOSED FLOOR PLAN  
Scale: 1/4"=1'-0"

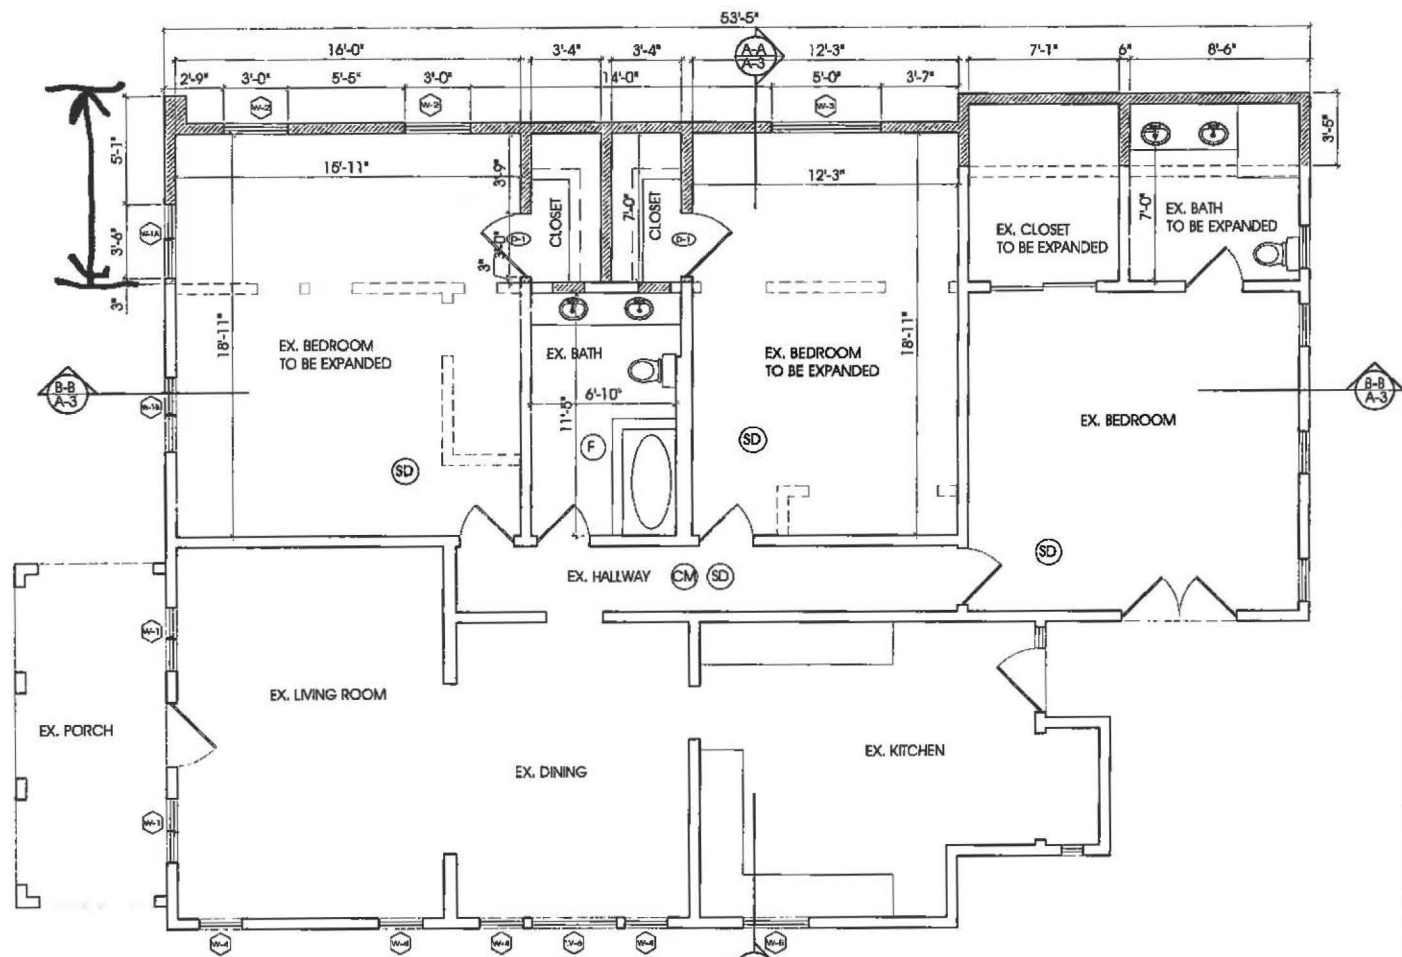

1 EXISTING FLOOR PLAN  
Scale: 1/4"=1'-0"
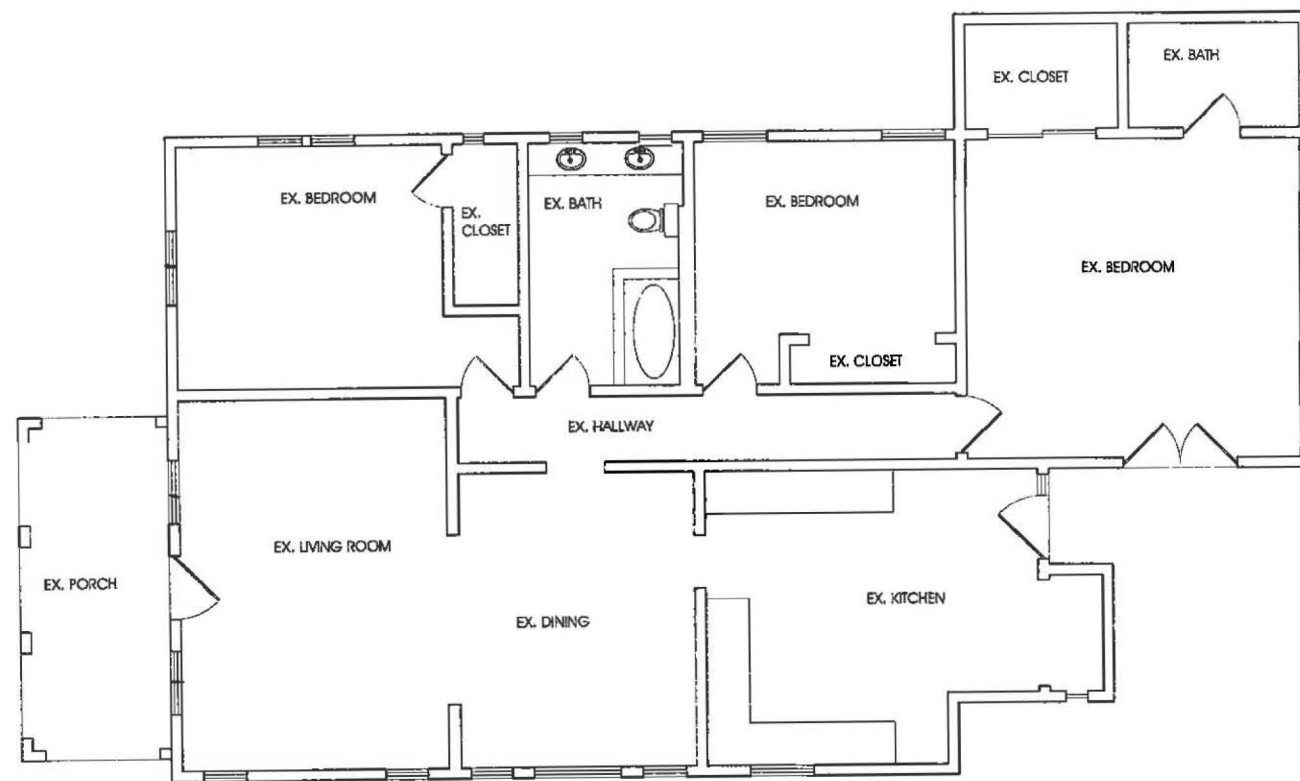
### LEGEND

- EX. WALL TO REMAIN
- PROPOSED WALL
- EX. WALL TO BE REMOVED

(SD) HARD-WIRED SMOKE DETECTOR WITH BATTERY BACK UP. A SMOKE DETECTOR SHALL BE INSTALLED IN EACH SLEEPING ROOM AND AT A POINT CENTRALLY LOCATED IN THE CORRIDOR OR AREA GIVING ACCESS TO EACH SLEEPING AREA. BATTERY OPERATED SMOKE DETECTOR PERMITTED IN EXISTING CONSTRUCTION.

(F) ELECTRICAL FAN WITH MIN. 5 AIR CHANGE PER HOUR TO OUTSIDE. ELECTRICAL FAN MUST BE CONNECTED TO THE LIGHT SWITCH.

(CM) CARBON MONOXIDE DETECTOR

(N-1) PROVIDE 72" NON-ABSORBENT WALL SURFACE IN ALL BATHTUB AND SHOWER COMPARTMENTS.

(W-1) WINDOW SYMBOL. SEE A-4.3 FOR WINDOW SCHEDULE

(D-1) DOOR SYMBOL.

### NEW DOOR SCHEDULE

#	DOOR SIZE	MAT.	TYPE	REMARKS
WIDTH	HEIGHT			
1	2'-8"	6'-8"	HOLLOW CORE	SWING

NOTE: ALL DOORS & WINDOWS SHALL MEET CITY OF GLENDALE'S SECURITY ORDINANCE.

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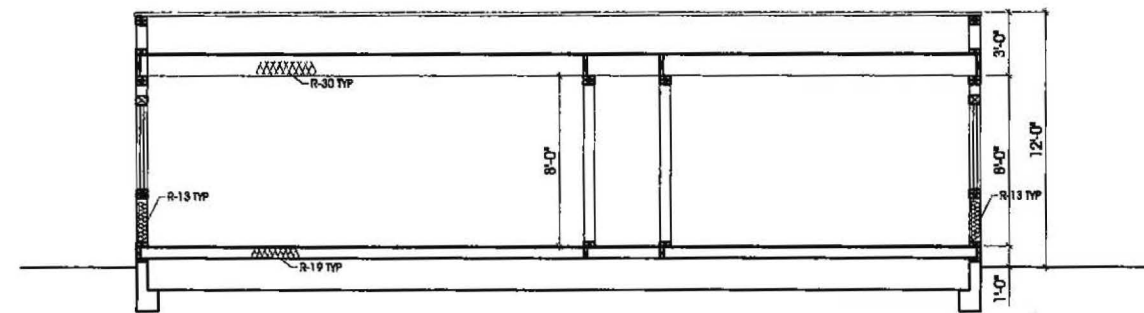
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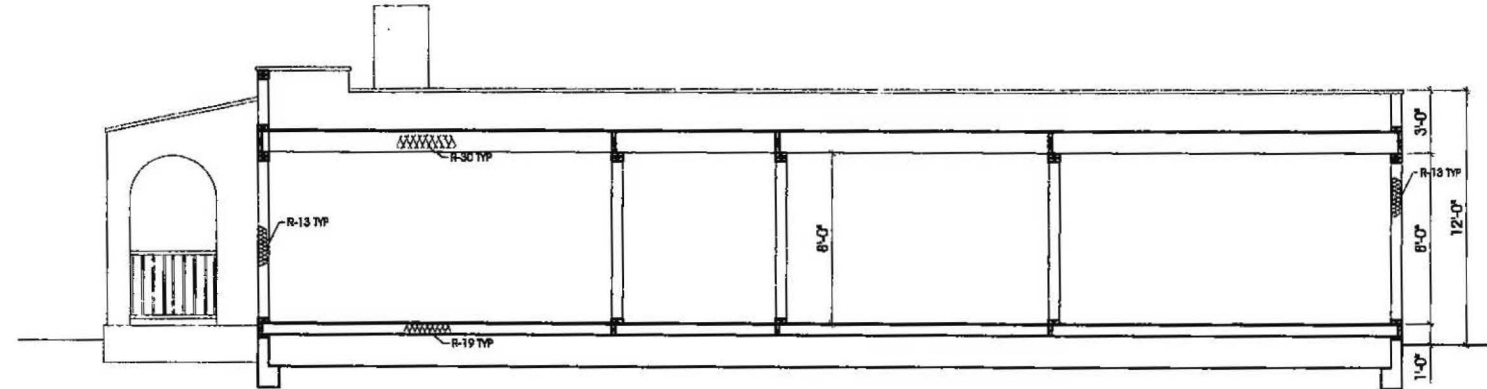
A-2

OF SHEETS




1 SECTION A-A

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2 SECTION B-B

Scale: 1/4"=1'-0"



3 ROOF PLAN

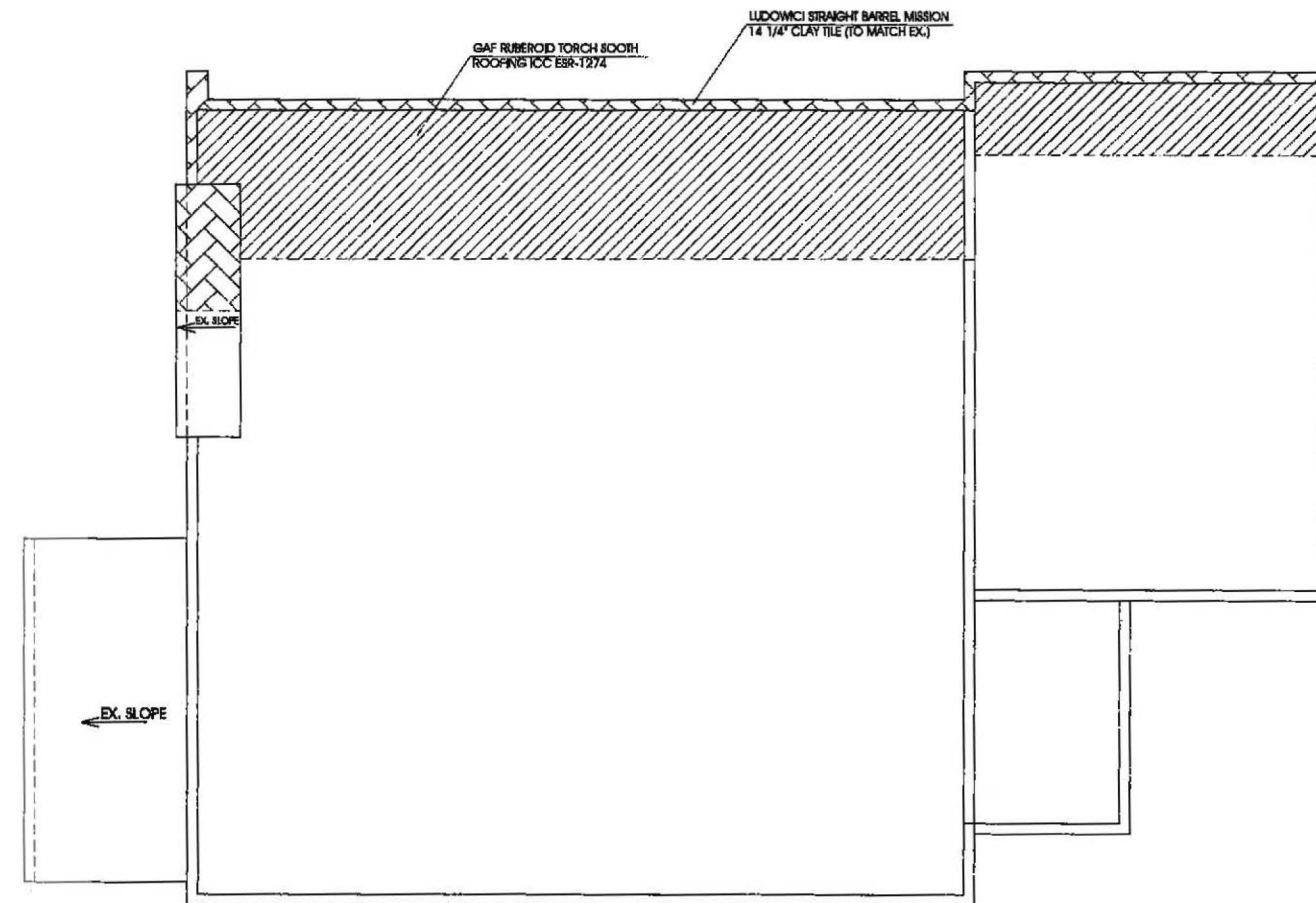Scale: 1/4"=1'-0"

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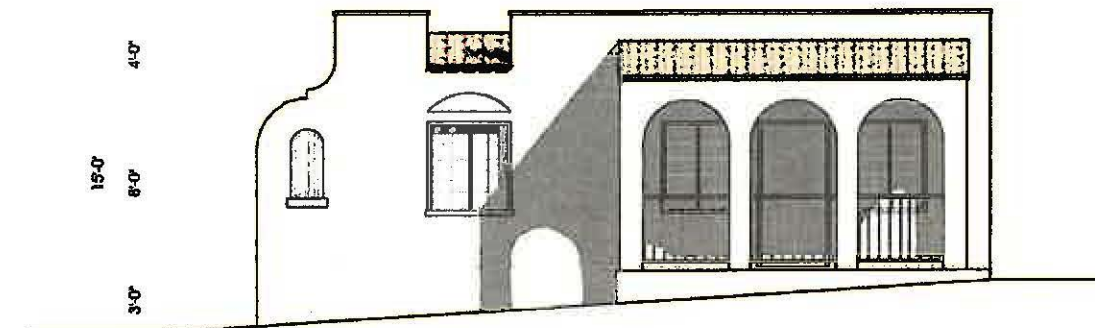
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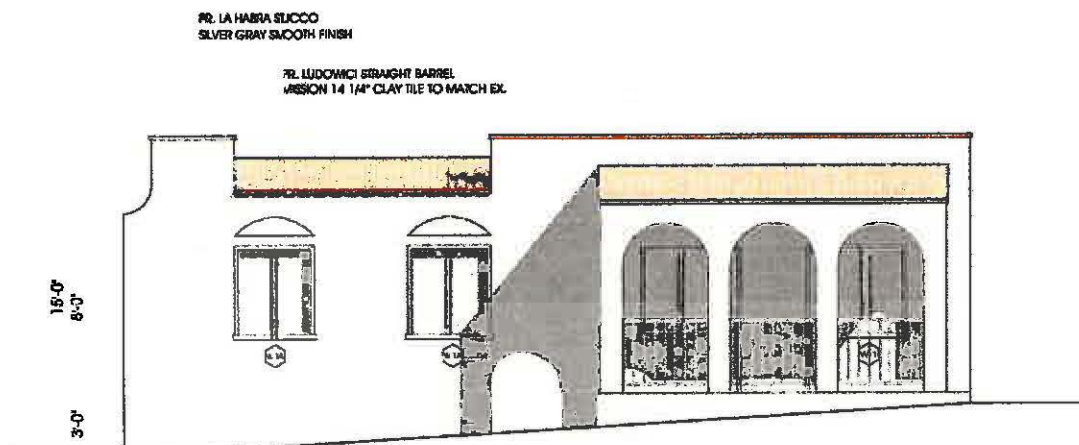
A-3

OF SHEETS





1 EX. SOUTH ELEVATION  
Scale: 1/4"=1'-0"



2 PROPOSED SOUTH ELEVATION  
Scale: 1/4"=1'-0"

PR. LA HABRA STUCCO  
SILVER GRAY SMOOTH FINISH

PR. LUDOWICI STRAIGHT BARREL  
MISSION 14 1/4" CLAY TILE TO MATCH EX.

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ADDITION TO EXISTING 1 STORY S.F.D.

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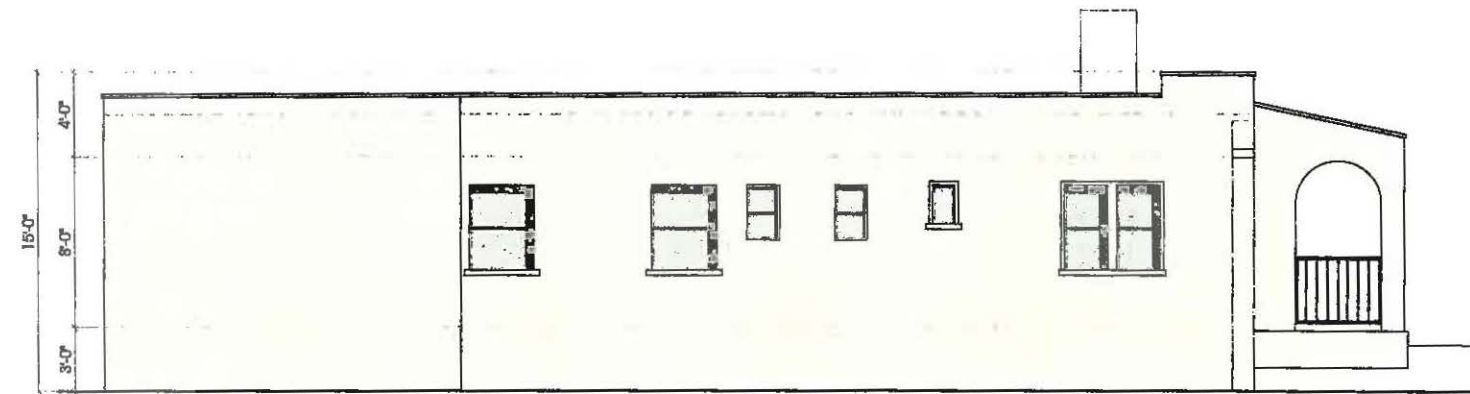
REVISIONS		
NO.	ISSUE	BY
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3	02.20.19	AM
4	03.25.19	AM

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CHECKED BY: ARAM M.  
DESIGN BY: ARAM M.  
SCALE: \_\_\_\_\_  
DATE: \_\_\_\_\_  
JOB NO: \_\_\_\_\_


SHEET NUMBER:

A-4.1


OF SHEETS




1 EX. WEST ELEVATION  
Scale: 1/4"=1'-0"

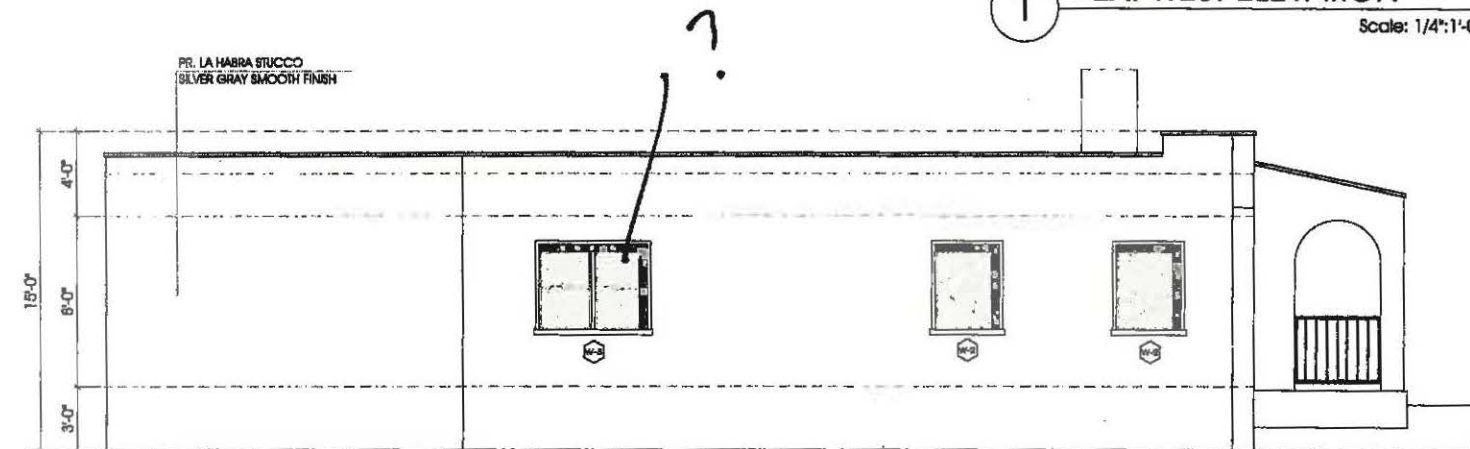

2 PROPOSED WEST ELEVATION  
Scale: 1/4"=1'-0"

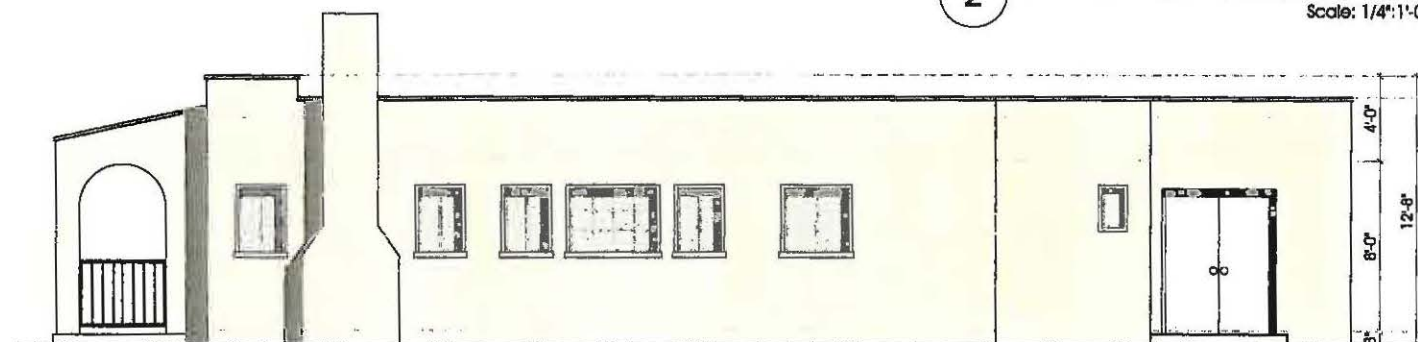

3 EX. EAST ELEVATION  
Scale: 1/4"=1'-0"

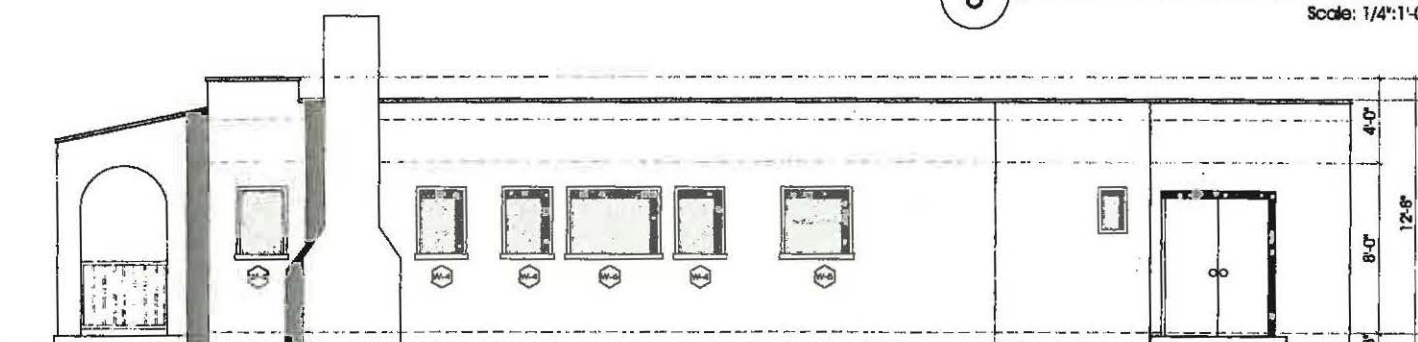

4 PROPOSED EAST ELEVATION  
Scale: 1/4"=1'-0"

NOTE: SEE SHEET A-4.3 FOR WINDOW SCHEDULE

ARCH-DESIGN  
& CONSTRUCTION CO., INC.  
  
TEL (818) 517-5224  
archdesignandcons@yahoo.com  
  
409 IRVING DR.  
BURBANK, CA 91504

OWNER  
YERVAND MINASYAN 818-631-6008

PROJECT  
ADDITION TO EXISTING 1 STORY S.F.D.

LOCATION  
1325 SONORA ST., GLENDALE, CA 91201

AVE

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3	02.20.19	AM
4	03.25.19	AM

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A-4.3

OF SHEETS




1 EX. SOUTH ELEVATION

Scale: 1/4"=1'-0"



2 PROPOSED SOUTH ELEVATION

Scale: 1/4"=1'-0"

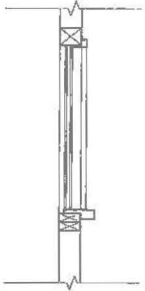

3 WINDOW SECTION TYP.


Scale: 1/2"=1'-0"

NEW WINDOW SCHEDULE


WINDOW NUMBER	QUANTITY	EXISTING WIDTH X HEIGHT	NEW WIDTH X HEIGHT	EXISTING MATERIAL	NEW MATERIAL	VISIBLE FROM STREET?	EXISTING OPERATION	NEW OPERATION	NEW FRAME TYPE	EXTERNAL GRID (SDL)	KEEP EXISTING SILL & FRAME?	BUILD NEW SILL & FRAME?	EXISTING EDGE DETAIL	NEW EDGE DETAIL	BEDROOM EGRESS	ENERGY EFFICIENT	TEMPERED GLASS	FIRE HAZARD ZONE	WINDOW WITHIN 18" OF FLOOR OR 40" OF DOOR
W-1	2	3'-6" X 4'-0"	3'-6" X 4'-0"	VINYL	VINYL	Y	UNKNOWN	DBL. CASEMENT	BLOCK	N	Y	N	WOOD	WOOD	N	Y	Y	N	Y
W-1A	1	-	3'-6" X 4'-0"	-	VINYL	Y	-	DBL. CASEMENT	BLOCK	N	-	Y	-	WOOD	Y	Y	N	N	N
W-1B	1	3'-6" X 4'-0"	3'-6" X 4'-0"	VINYL	VINYL	Y	UNKNOWN	DBL. CASEMENT	BLOCK	N	Y	N	WOOD	WOOD	Y	Y	N	N	N
W-2	2	-	3'-0" X 4'-0"	-	VINYL	Y	-	CASEMENT	BLOCK	N	-	Y	-	WOOD	Y	Y	N	N	N
W-3	1	-	5'-0" X 4'-0"	-	VINYL	Y	-	SINGLE HUNG	BLOCK	N	-	Y	-	WOOD	Y	Y	N	N	N
W-4	4	2'-0" X 3'-0"	2'-0" X 3'-0"	VINYL	VINYL	Y	UNKNOWN	CASEMENT	BLOCK	N	Y	N	WOOD	WOOD	N	Y	Y	N	N
W-5	1	3'-0" X 3'-0"	3'-0" X 3'-0"	VINYL	VINYL	Y	UNKNOWN	SINGLE HUNG	BLOCK	N	Y	N	WOOD	WOOD	N	Y	N	N	N
W-6	1	4'-0" X 3'-0"	4'-0" X 3'-0"	WOOD	VINYL	Y	FIXED	FIXED	BLOCK	N	Y	N	WOOD	WOOD	N	Y	N	N	N

WINDOW SCHEDULE NOTES:  
1. ALL WINDOWS 0.32 MAX U-FACTOR AND 0.25 MAX SHGC  
2. FOR WINDOW SECTION DETAIL FOR ALL WINDOWS SEE DET. 3 ON THIS PAGE  
3. NO INTERNAL GRIDS ALLOWED




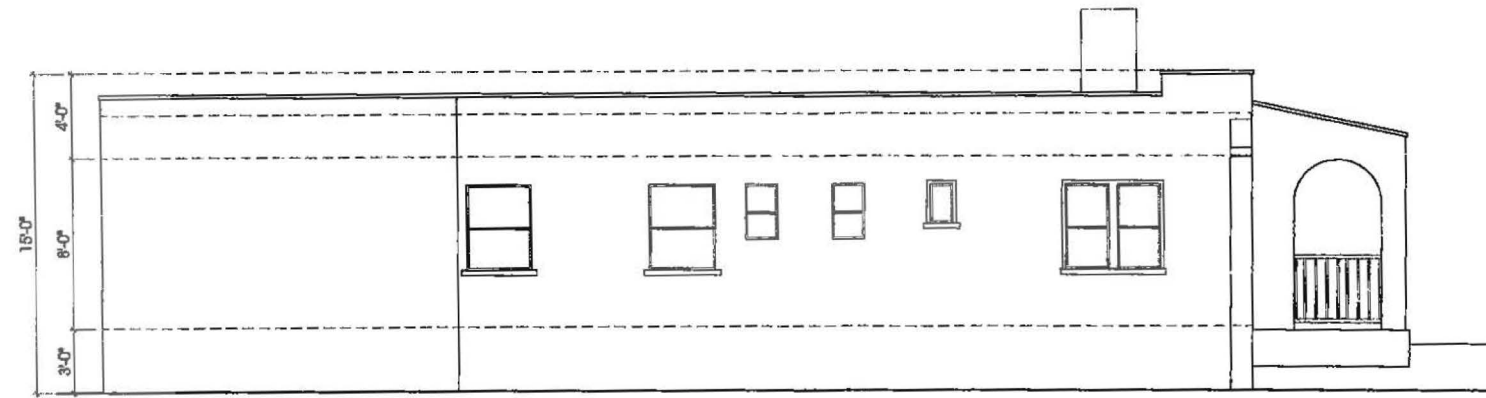


1 EX. WEST ELEVATION  
Scale: 1/4"=1'-0"

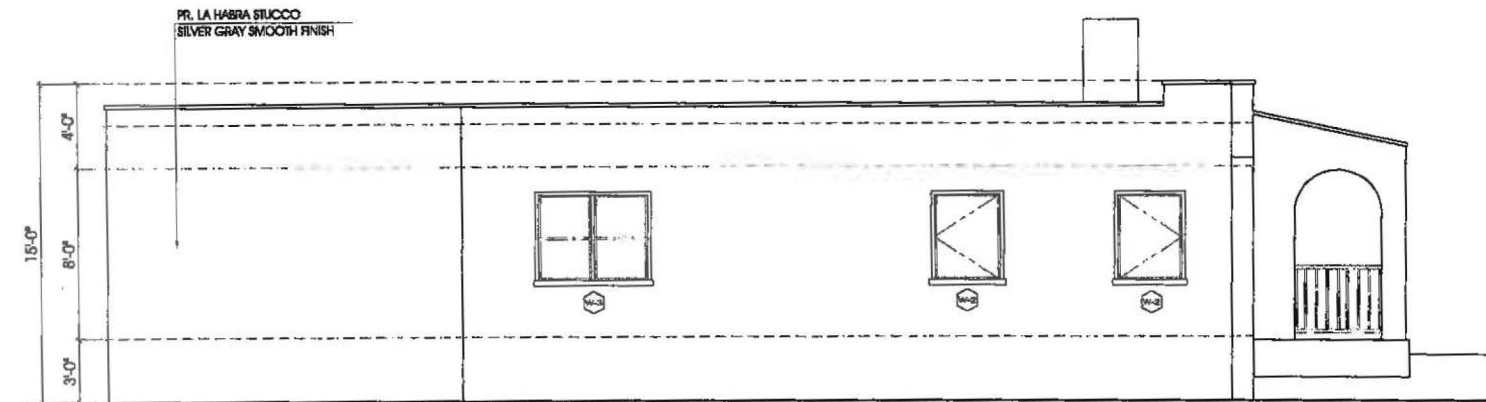

2 PROPOSED WEST ELEVATION  
Scale: 1/4"=1'-0"

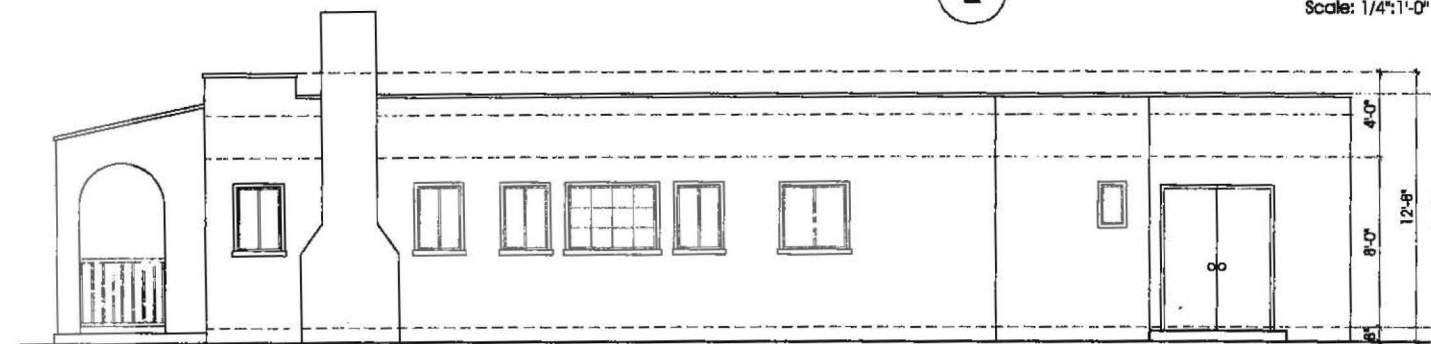

3 EX. EAST ELEVATION  
Scale: 1/4"=1'-0"

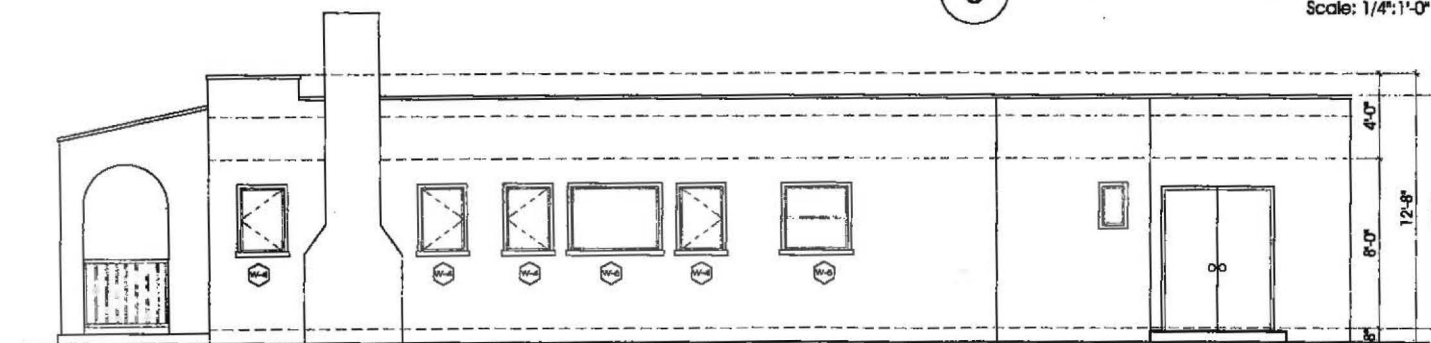

4 PROPOSED EAST ELEVATION  
Scale: 1/4"=1'-0"

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OF SHEETS

NOTE: SEE SHEET A-4.3 FOR WINDOW SCHEDULE

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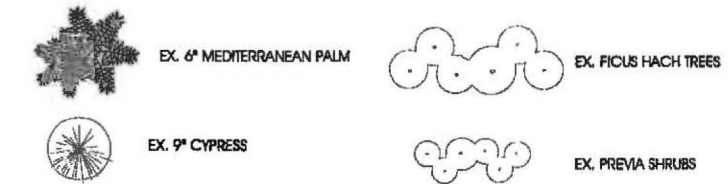
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NO.	ISSUE	BY
2	02.13.19	AM


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DESIGN BY	ARAM M.
SCALE	
DATE	
JOB NO.	
SHEET NUMBER	

L-1

# LEGEND



NOTE: ALL EXISTING LANDSCAPING TO REMAIN. ( NO CHANGES )

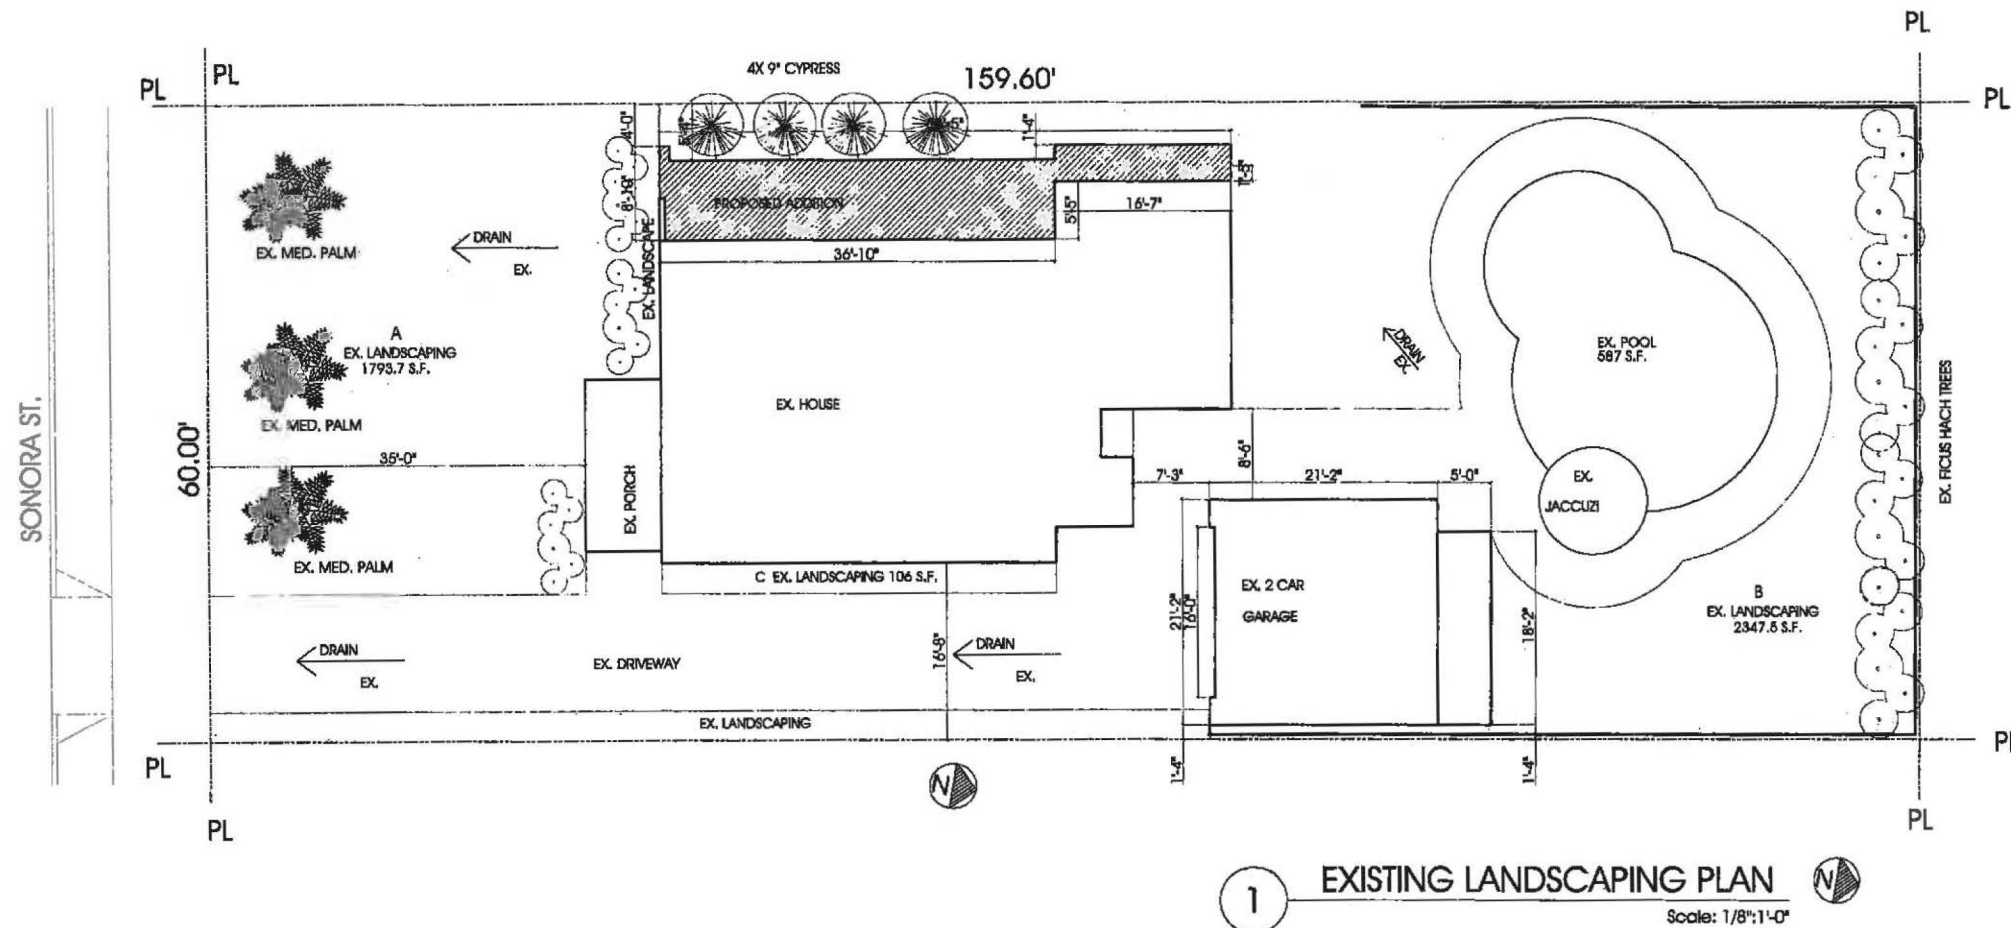

1 EXISTING LANDSCAPING PLAN Scale: 1/8"=1'-0"





RENDERED PERSPECTIVE

PROJECT: 1325 SONORA AVE. GLENDALE, CA 91201







**RENDERED PERSPECTIVE**

**PROJECT: 1325 SONORA AVE. GLENDALE, CA 91201**

